
## **DEMOLITION NOTES:**

- 1. DEMOLITION DRAWING IS DIAGRAMMATIC IN NATURE; NO ATTEMPT HAS BEEN MADE TO SHOW ALL EXISTING ELECTRICAL WORK. IN AREAS INDICATED TO BE RENOVATED, ALL EXISTING ELECTRICAL WORK IS TO REMAIN UNLESS OTHERWISE NOTED. WHEN AN ITEM IS INDICATED TO BE REMOVED, REMOVE ALL ASSOCIATED ELECTRICAL WORK BACK TO POINT OF SOURCE.
- 2. WHERE WORK PASSES THROUGH THE RENOVATION AREA TO SERVE OTHER PORTIONS OF THE BUILDING, OR WORK IN THE RENOVATION AREA INDICATED TO REMAIN, IT SHALL BE SUITABLY RELOCATED AND THE SYSTEMS RESTORED TO NORMAL. COORDINATE ANY OUTAGES WITH OWNER 7 DAYS IN ADVANCE.
- 3. WORK INDICATED TO REMAIN SHALL BE SUITABLY PROTECTED AGAINST
- 4. ALL EXISTING COMMUNICATION CABLING SHALL REMAIN. NEATLY COIL-UP ALL CABLING IN CEILING SPACE. COORDINATE ALL WORK WITH OWNER.

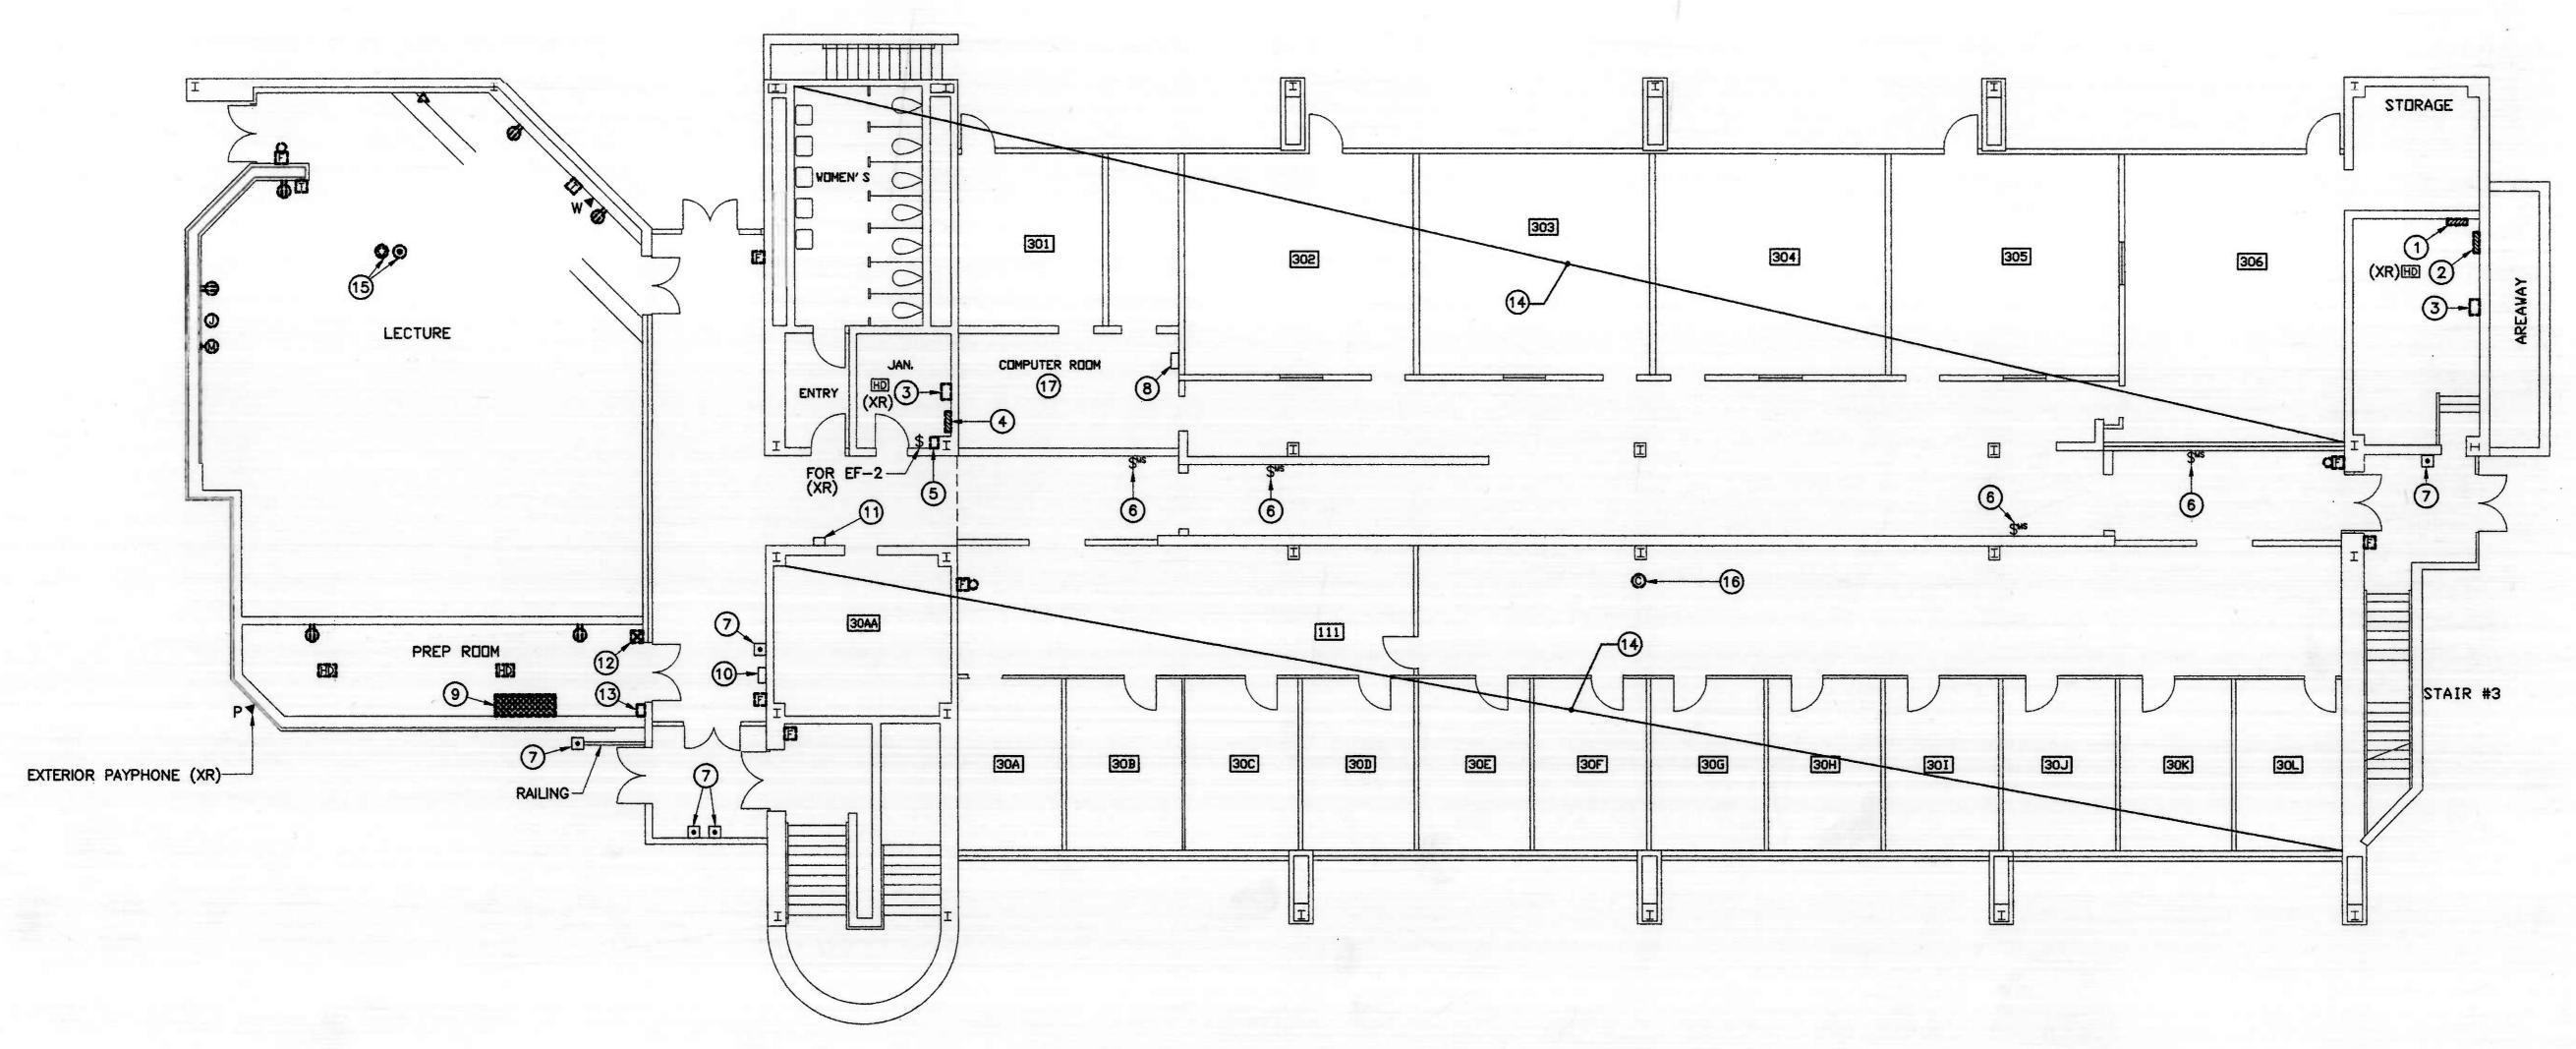

FIRST FLOOR PLAN - POWER & COMMUNICATIONS - DEMOLITION


SCALE: 1/8" = 1'-0"



- DISCONNECT AND REMOVE EXISTING EXHAUST FAN-1 STARTER. EXHAUST FAN IS LOCATED ON THE ROOF. REFER TO DRAWING E-12 FOR LOCATION.
- DISCONNECT AND RELOCATE EXISTING TELEPHONE PANEL TO STORAGE ROOM AND RECONNECT AS REQUIRED. EXTEND CABLING AS REQUIRED, NO SPLICES SHALL SHALL BE MADE UNLESS APPROVED BY THE OWNER. REFER TO DWG. E-7 FOR NEW LOCATION.
- 4 ALL EXISTING ELECTRICAL DEVICES IN THIS AREA SHALL REMAIN EXCEPT FIRE ALARM DEVICES SHALL BE REMOVED UNLESS OTHERWISE NOTED. PANELBOARDS AS REQUIRED.
- 15) REMOVE EXISTING FLOOR OUTLETS AND PATCH FLOOR TO MATCH ADJACENT AREA.
- DISCONNECT, REMOVE AND RELOCATE EXISTING DEVICE TO NEW CEILING. RECONNECT TO EXISTING SYSTEMS AS REQUIRED.
- 17) ALL EXISTING COMMUNICATION CABLING TERMINATES IN THE COMPUTER ROOM. ALL NEW COMMUNICATION CABLING SHALL TERMINATE IN THE COMPUTER ROOM, WITH FINAL CONNECTIONS BY THE OWNER. PROVIDE 20 FOOT OF CABLE SLACK.

## DRAWING NOTES:

- 1 REMOVE EXISTING PANEL "LP1" FPE 277/480V, 3Ø, 4W, 100 AMP MLO. RELOCATE ALL EXISTING CIRCUITS TO REMAIN TO NEW PANELBOARD.
- 2 REMOVE EXISTING PANEL "P1" FPE 120/208V, 3Ø, 4W, 225 AMP MLO. RELOCATE ALL EXISTING CIRCUITS TO REMAIN TO NEW PANELBOARD.
- 3 REMOVE EXISTING DUAL-LITE BATTERY UNIT. 120V AC INPUT/12V, 10.
- REMOVE EXISTING PANEL "P2" FPE 120/208V, 30, 4W, 225 AMP MLO. RELOCATE ALL EXISTING CIRCUITS TO REMAIN TO NEW PANELBOARD.
- TEMOVE EXISTING SQUARE "D" LOAD CENTER 120/208V, 30, 4W, 225 AMP MLO. RELOCATE ALL EXISTING CIRCUITS TO REMAIN TO NEW PANELBOARD.
- 6 EXISTING MOTION SENSOR THAT CONTROLS AUTOMATIC CORRIDOR DOORS WILL REMAIN. MAINTAIN EXISTING ELECTRICAL CONNECTIONS AND EQUIPMENT.
- 7 EXISTING PUSH PAD THAT CONTROLS AUTOMATIC EXTERIOR DOORS WILL REMAIN. MAINTAIN EXISTING ELECTRICAL CONNECTIONS AND EQUIPMENT.
- 8 EXISTING HONEYWELL SECURITY CONTROL PANEL TO REMAIN. MAINTAIN EXISTING ELECTRICAL CONNECTIONS AND EQUIPMENT.
- 9 REMOVE EXISTING DIMMING CONTROL PANEL, FEEDER AND ALL CIRCUITS THAT CONTROLS LIGHTING IN THE LECTURE HALL.
- (10) EXISTING EDWARDS SECURITY MONITORING PANEL TO REMAIN. MAINTAIN ALL SECURITY DEVICES THROUGHOUT THE BUILDING.
- (1) EXISTING EMERGENCY "PUSH-TO-CALL" TELEPHONE BOX TO REMAIN.

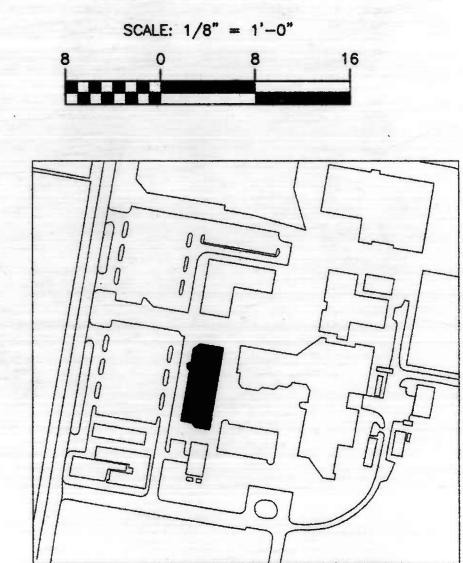

RENOVATIONS TO CLASSROOM BUIL CCBC DUNDALK C 7200 Sollers Point Roac Baltimore, Maryland 21

No. Date Revisions

Project No.: 0045-01 Date: 1/18/02

Scale: AS NOTED Sheet Title: FIRST FLOOR PLAN -POWER & COMMUNICATION -DEMOLITION

D-022155